

October 16, 2023

Project:

Morrison Fourplex Infill, Kelowna, BC

Re:

Design Rationale

1.0 PROJECT DESCRIPTION

The Morrison Avenue infill proposal seeks to readapt the common standards of the multifamily complex on what was once a single-family zoned lot, near the heart of the Pandosy core. Infill projects will become a major facet of increasing density around our urban cores in the coming years. Effort needs to be placed into creating a standard that can be modelled for future infill development, so that ideas and forms can be translated into something of a city-wide language in a local context where individual architecture is so often vastly different from its neighbours.

This project looks to create a new standard for infill projects in the City of Kelowna. Generally, these projects often look quite distinct from their surroundings given the need to provide access to the site from both a laneway for cars and the street for people - for all units. This often creates masses on the street that can make these forms imposing as they rise to become taller and narrower to ensure each home has sufficient access to street circulation. This massing type makes landscaping a byproduct of the form proposed, meaning these already distinct masses often have less opportunity to be eased into their surroundings through future foliage growth. These street front masses create backyard spaces that often get limited sunlight due to their height, while also limiting the privacy in these spaces (and so too the eagerness from residents to use them). Nothing happens where nothing happens and something happens where something happens — we would like to create common spaces on site where something can happen, to encourage others to join in either actively or passively, and we feel these commonalities are crucial on a site where potentially four families that might be strangers to one another will live.

In this we have some key motives for the project:

- 1. Ensure privacy is maintained in units,
- 2. Provide outdoor space that can be "claimed" by individual units on the shared lot,
- 3. Provide space for the movement of people,
- 4. Provide space for the infill growth of vegetation and the elements in the spaces left unbuilt,
- 5. Ensure the building is aware of its surrounding built context.
- 6. Encourage low-barrier socialization opportunities, which can be quite simple and mundane

The project features four units oriented in two "T" blocks. Two units are oriented perpendicular to the road, while two are oriented parallel to it. Of the two masses, one of these perpendicular units forms with one of the parallel to form the "T" shape in plan. The intersection of these forms creates spaces that differentiate the more publicly visible portions of the lot from an interior private courtyard. A covered walkway on ground level comes at the intersection of the two forms, creating a "gateway" moment for the interior yard space. This interior yard space is intended to act as something of a personalized garden space for the homes, where planters and pots can be brought in to fill out the space around a central tree. This is to help create outdoor spaces that are both attractive to be in (so too increasing the chance of social encounters between neighbours), while having the added benefit of increased privacy as the plants and the trees in this courtyard space grow and fade out direct views into interior spaces.

Units have been designed in such a way to ensure better privacy from both the form and the layouts of the interior rooms inside. Two of the units have ground-oriented bedrooms with upper-level living spaces, while two have upper level bedrooms with lower level living spaces. The idea here is that everyone will be using the living spaces and the bedroom spaces around similar "peak" times. With different units sleeping mainly on different floors, there can be better lookouts into the surrounding courtyard without compromising privacy through direct views between bedrooms. Access to the garage and garbage access spaces are made off the back alleyway.

2.0 URBAN CONNECTIVITY

The project is in an MF1 (Core Area Neighbourhood). This gives it great access to the rapidly developing Pandosy Core, very quick access to local waterfront amenities, and convenient distances to public transit or established walking and cycling pathways. This places the lot in a great position to allow its residents to engage with its surroundings in a plethora of ways (instead of car transit alone). Pandosy is very much a satellite of the downtown core, and so has convenient access to all daily needs within its locale.

3.0 SUSTAINABILITY

Sustainability encompasses far more than energy usage. Regarding this energy though, both the construction process and the materiality of the building will be cognizant of the effects of construction and embodied energy involved. Thermal bridging will be minimized with continuous insulation, and windows facing direct sunlight will have increased glazing coefficients to help better control interior climatic conditions. Solar shading will be used, and a reliance on establishing good and healthy foliage on site will play a role in this (blocking the summer sun and shedding leaves to let in the winter sun). Steps in the façade and covered paths will protect entryways and materials vulnerable to water. Longevity of the assemblies are ensured through careful detailing and protection from the elements in forms like these steps.

Foliage is vital to this project. It will ultimately be what helps to ease these homes into their context over time, and their presence will create microclimates that help the building occupants to adapt to intense weather more readily. The courtyard design allows each home to experience some form of cross-ventilation, while actively encouraging residents to get outside and get moving. Care for the home is instilled through personal patios and garden spaces which will be provided with enough light to establish good growth. The home is designed for people first. The central path is accessible on foot or by bike. Cars are pushed to the laneway garage and hidden from the street. Given we realize these early infill projects will inevitably become precedents and standards for future developments, we have tried to make the building attractive yet economical. Two of the units are identical, the other two quite similar. This model can be multiplied and adapted for different material contexts. The building forms are simple, they leave ample space for foliage, and they are focused on the human scale rather than the scale of a motor vehicle.

4.0 CRIME PREVENTION

Crime prevention comes from many different conditions. Regarding the site alone, sufficient measures have been taken to help promote community amongst the residents, and in doing so, helping to prevent and disincentivize crime through creating valued spaces that are desirable to be in and visually accessible.

5.0 LANDSCAPING

Attractive outdoor space is key to this site and the motives for designing it as we have proposed. With limited hardscaping in the paths and deck spaces, we have left ample space for smaller plants, bushes, flowers, vines and potted medium to grow with adequate sunlight around the building. Space is left for some larger trees to take root, with space for medium or smaller size trees available in the interior courtyard. This foliage will help to maintain privacy between units, provide cooling through evapotranspiration and shade from the sun during the warmer months, and provide ample sensorial stimulus to help ease the space from the surrounding City. Please refer to the landscape drawings for details.


6.0 **SUMMARY**

Bluegreen Architecture's design team feels that the care for the human scale, the desire for higher Downtown density, as well as the care for the landscape in a dense lot in the midst of the city fabric, will help to create a meaningful space for the residents that come to occupy this space while providing a solid base of reference for future developments in the City. We hope to play a meaningful part in creating more meaningful, livable, human scaled and beautiful neighbourhoods in Kelowna to help marry the beauty of our surrounding landscape with what could be a beautiful architectural landscape, should we value it enough to care for it intentionally.

We look forward to your support for all this project brings to our community, and this unique opportunity to address and create an affordable living experience.

Respectfully submitted,

Aaron Whalen, Associate & Project Designer, Bluegreen Architecture Kieran Mortimer, Project Designer, Bluegreen Architecture

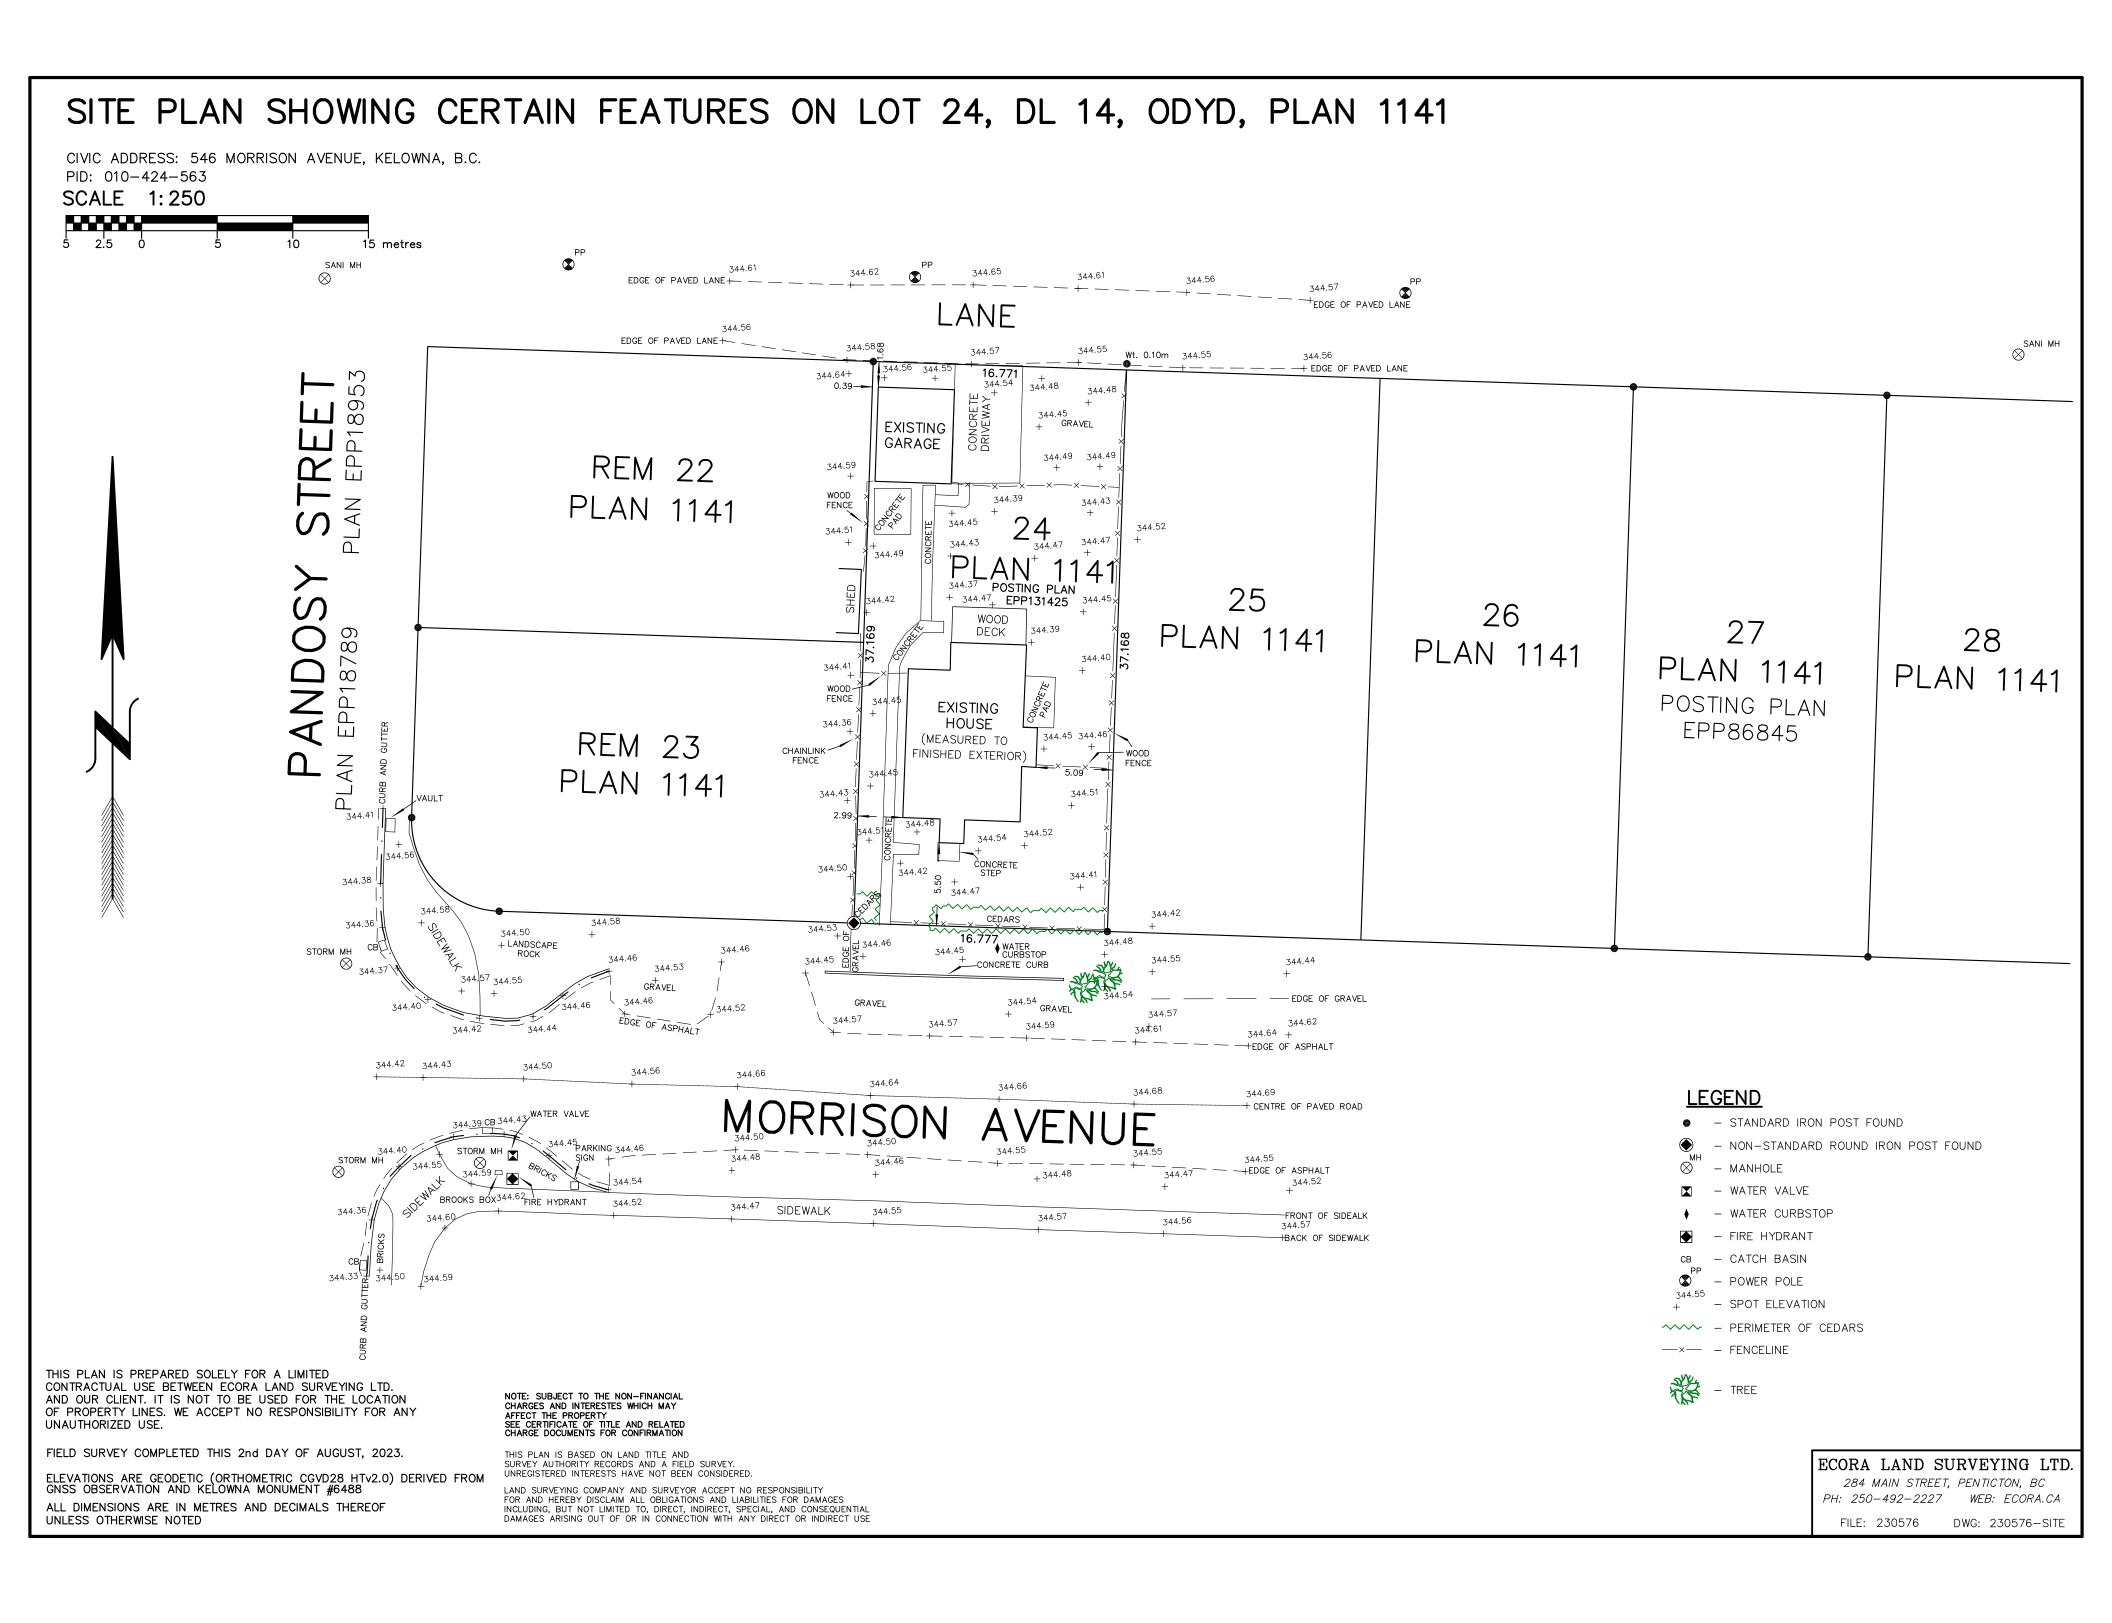



MORRISON AVE. INFILL

ISSUING FOR DP

FOURPLEX INFILL HOUSING 546 MORRISON AVE. 2023-09-25

CONSULTANTS:

ARCHITECTURAL:

BLUEGREEN

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CLIENT:

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| ARCHITECTURAL DRAWING LIST | | | | |
|----------------------------|----------------------|--|--|--|
| EET NUMBER | SHEET NAME | | | |
| A0.0 | COVER SHEET | | | |
| A1.0 | SITE PLAN | | | |
| A1.1 | ZONING AND DATA | | | |
| A1.2 | STREETFRONT | | | |
| A2.0 | FLOOR PLAN - LEVEL 1 | | | |
| A2.1 | FLOOR PLAN - LEVEL 2 | | | |
| A2.2 | FLOOR PLAN - ROOF | | | |
| A2.3 | UNIT CALLOUT | | | |
| A2.4 | UNIT CALLOUT | | | |
| A2.5 | SECTIONS | | | |
| A3.0 | ELEVATIONS | | | |
| A3.1 | ELEVATIONS | | | |
| A3.2 | MATERIAL BOARD | | | |
| A3.3 | RENDERS | | | |

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#100-1353 Ellis Street Kelowna, BC V1Y 1Z9 p:236.420.3550

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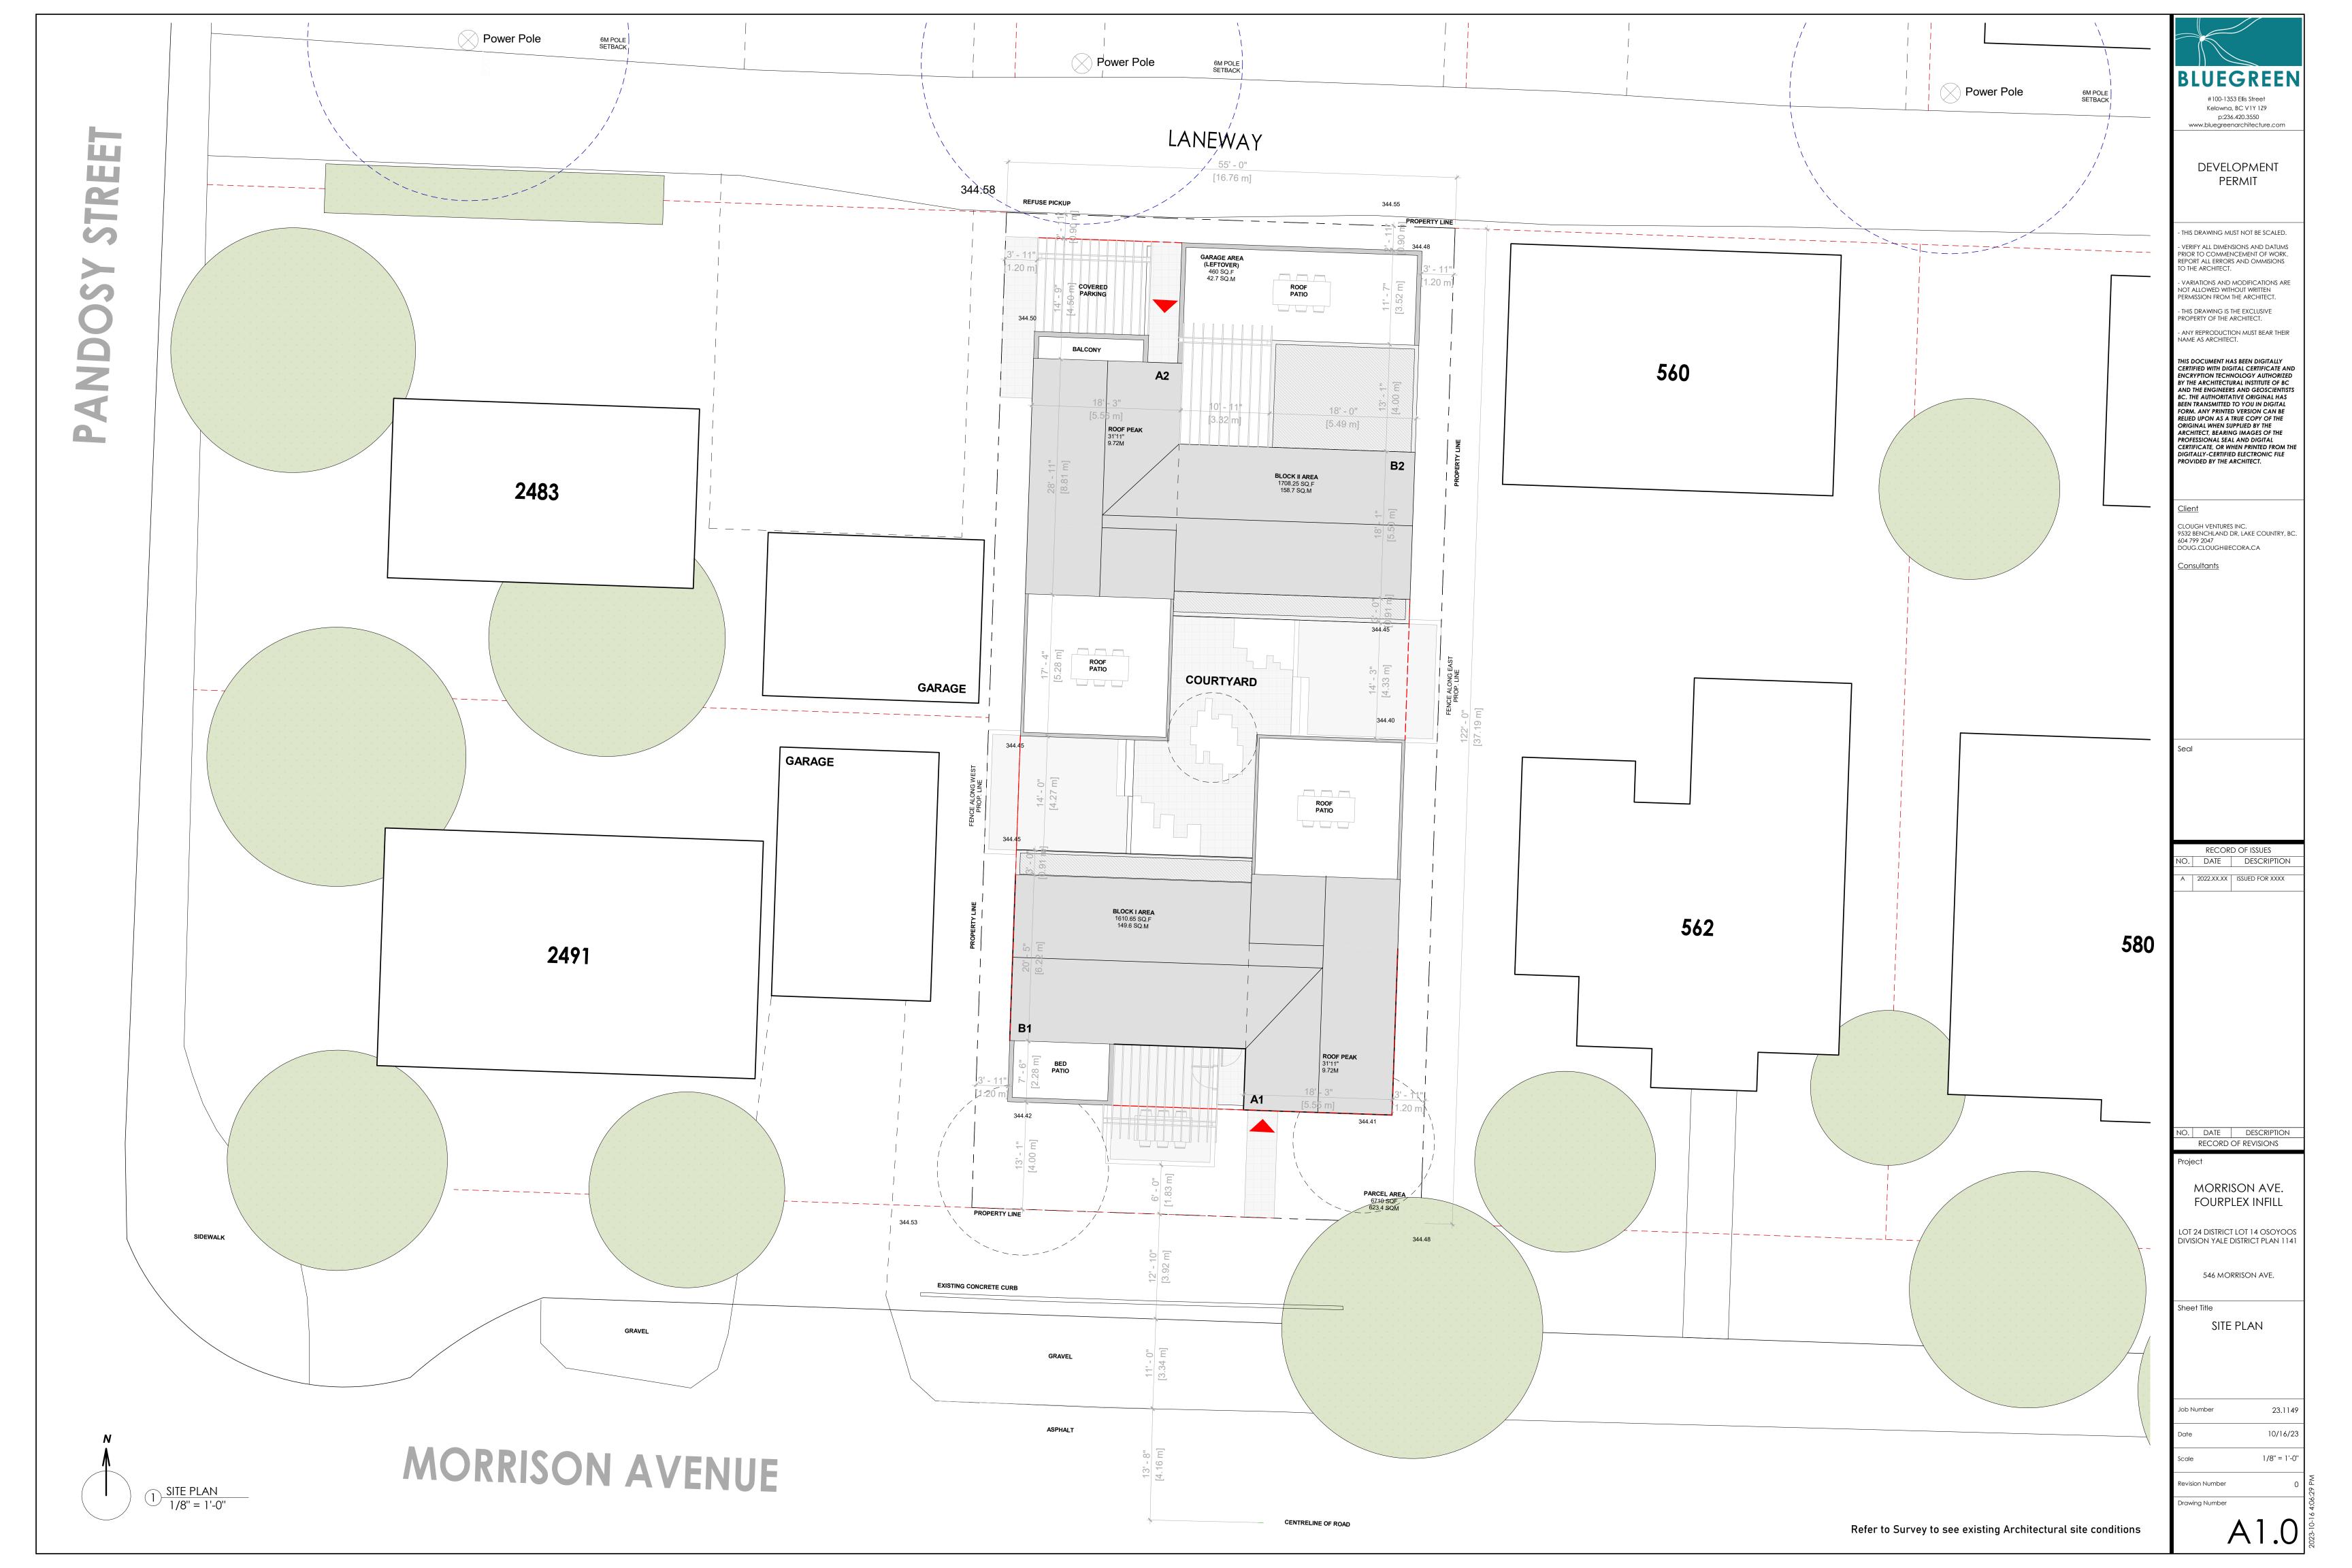
RECORD OF REVISIONS

MORRISON AVE. FOURPLEX INFILL

LOT 24 DISTRICT LOT 14 OSOYOOS DIVISION YALE DISTRICT PLAN 1141

546 MORRISON AVE.


COVER SHEET



ZONING ANALYSIS - 546 MORRISON AVE.

| MORRISON AVE. FOURPLEX INFILL 546 MORRISON AVE. | | | | | |
|---|---------------------------------|---------------------------------------|--|--|--|
| CURRENT ZONING: RU4 | REQUIRED | PROVIDED | | | |
| | RU4 - SINGLE FAMILY | MF1 C-NHD - INFILL FOURPLEX | | | |
| PRINCIPLE USE | | | | | |
| PARCEL SIZE | 277.5 m ² | 623 m² | | | |
| LOT WIDTH | 7.5 m | 16.76 m 37.19 m | | | |
| LOT DEPTH | 30.0 m | | | | |
| NET FLOOR AREA | 499 m² (0.8 FAR) 623 m² (1 FAR) | 446m² | | | |
| BUILDING FOOTPRINT (INC. COVERED AREAS) | N/A | 305 m² | | | |
| PARKADE FLOORPLATE | N/A | 67.2m² | | | |
| MAIN FLOOR FLOORPLATE | N/A | 236m² | | | |
| FLOOR AREA RATIO | 0.8 | 0.73 | | | |
| MAXIMUM LOT COVERAGE | 55% | 49.0% | | | |
| SITE COVERAGE (INC. PARKING AND DRIVEWAYS) | 75% | 68% | | | |
| MAXIMUM BUILDING HEIGHT | 8.0 m and 2 Storeys | 8.0 m and 2 Storeys | | | |
| | FRONT YARD - 4M - 13'-1 1/2" | FRONT YARD (WEST) - 4M | | | |
| CETTO A GIVE | SIDE YARD - 1.2M - 3'-11 21/86" | SIDE YARD (NORTH) - 1.2M | | | |
| SETBACKS | REAR YARD - 0.9M - 2'-11 3/7" | REAR YARD (EAST) - 0.9M | | | |
| | SIDE YARD - 1.2M - 3'-11 1/4" | SIDE YARD (SOUTH) - 1.2M | | | |
| | TOTAL UNITS = 4 | TOTAL UNITS = 4 (3 BED) | | | |
| DARWING CALCULATIONS | 1 SPACES / UNIT = 4 | PRIVATE GARAGE STALLS = 3 + 1 CARPORT | | | |
| PARKING CALCULATIONS | VISITOR (0.14/UNIT) = 1 | VISITOR = USE ON STREET PARKING | | | |
| | TOTAL REQUIRED = 4 | TOTAL PROVIDED = 4 | | | |

| FIRST FLOOR | NO. | SF | SM | TOTAL SF | TOTAL SM | POS (SF) | POS (SM) | TOTAL POS (SF) | TOTAL POS (SM) |
|----------------|-----|---------|-------|----------|----------|----------------|----------------|----------------|----------------|
| UNIT A1 | 1 | 519.6 | 48.27 | 519.6 | 48.27 | 0 | 0 | 0 | 0 |
| UNIT A2 | 1 | 519.6 | 48.27 | 519.6 | 48.27 | 0 | 0 | 0 | 0 |
| UNIT B1 | 1 | 581.7 | 54.04 | 581.7 | 54.04 | 422 | 39.21 | 422 | 39.21 |
| UNIT B2 | 1 | 467 | 43.39 | 467 | 43.39 | 233 | 21.65 | 233 | 21.65 |
| TOTAL | 4 | | | 2087.9 | 193.97 | | | 653 | 60.86 |
| 2ND FLOOR PLAN | NO. | SF | SM | TOTAL SF | TOTAL SM | POS (SF) | POS (SM) | TOTAL POS (SF) | TOTAL POS (SM) |
| UNIT A1 | 1 | 773.1 | 71.82 | 773.1 | 71.82 | 0 | 0 | 0 | 0 |
| UNIT A2 | 1 | 773.1 | 71.82 | 773.1 | 71.82 | 47 | 4.37 | 47 | 4.37 |
| UNIT B1 | 1 | 548.6 | 50.97 | 548.6 | 50.97 | 90 | 8.36 | 90 | 8.36 |
| UNIT B2 | 1 | 703.25 | 65.33 | 703.25 | 65.33 | 455 | 42.27 | 455 | 42.27 |
| TOTAL | 4 | | | 2798.05 | 259.95 | | | 592 | 55 |
| 3RD FLOOR PLAN | NO. | SF | SM | TOTAL SF | TOTAL SM | POS (SF) | POS (SM) | TOTAL POS (SF) | TOTAL POS (SM) |
| UNIT A1 | 1 | 21 | 1.95 | 21 | 1.95 | 292 | 27.13 | 292 | 27.13 |
| UNIT A2 | 1 | 21 | 1.95 | 21 | 1.95 | 292 | 27.13 | 292 | 27.13 |
| UNIT B1 | 0 | 0 | 0 | 0 | 0 | 0 | 0 | 0 | 0 |
| UNIT B2 | 0 | 0 | 0 | 0 | 0 | 0 | 0 | 0 | 0 |
| TOTAL | 2 | | | 42 | 3.9 | | | 584 | 54.26 |
| | | | | | | | | | |
| TOTAL | NO. | SF | % | TOTAL SF | TOTAL SM | REQ'D POS (SF) | REQ'D POS (SM) | TOTAL POS (SF) | TOTAL POS (SM) |
| UNIT A1 | 1 | 1314.2 | 25% | 1314 | 122.07 | // | // | 292 | 27.13 |
| UNIT A2 | 1 | 1314.2 | 25% | 1314 | 122.07 | // | // | 339 | 31.49 |
| UNIT B1 | 1 | 1130.3 | 25% | 1130 | 104.98 | // | // | 512 | 47.57 |
| | _ | 4470.05 | 0=0/ | 4470 | 400 7 | 11 | 11 | 600 | 62.02 |
| UNIT B2 | 1 | 1170.25 | 25% | 1170 | 108.7 | // | // | 688 | 63.92 |

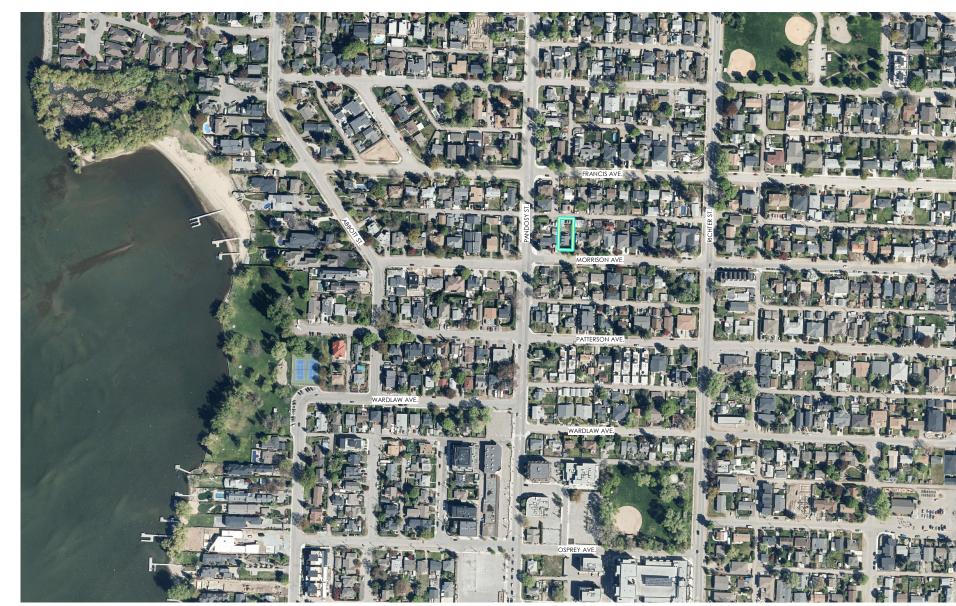


SITE VIEW - AERIAL OF PANDOSY CORE



SITE VIEW - FROM MORRISON AVE. TOWARDS PANDOSY ST.



SITE VIEW - FRONT OF 546 MORRISON AVE.

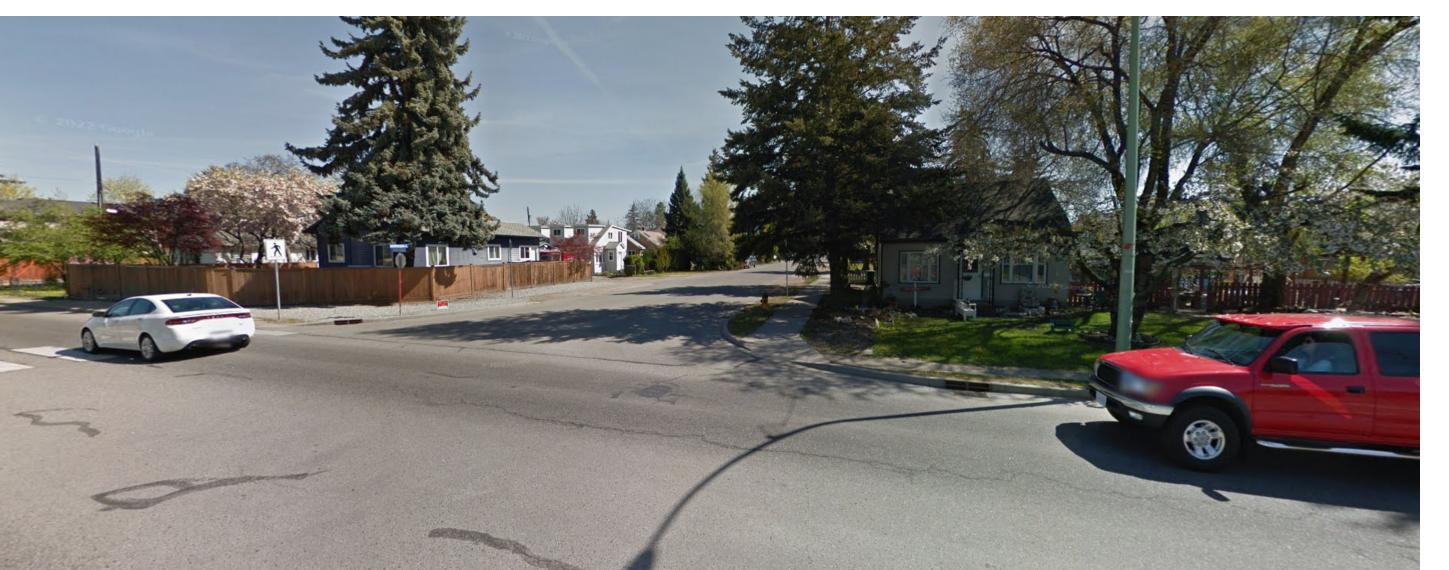

SITE VIEW - FROM PANDOSY ST.



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Project

MORRISON AVE. FOURPLEX INFILL

LOT 24 DISTRICT LOT 14 OSOYOOS DIVISION YALE DISTRICT PLAN 1141

546 MORRISON AVE.

ZONING AND DATA

bb Number 23.

Scale


Revision Number

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MORRISON AVE.

Streetfront elevation views of the adjacent sites and a panorama of the opposite side of the street directly across from the proposed site.





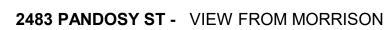

546 MORRISON AVE - PROPOSED SITE



562 MORRISON AVE.



VIEW ACROSS THE STREET



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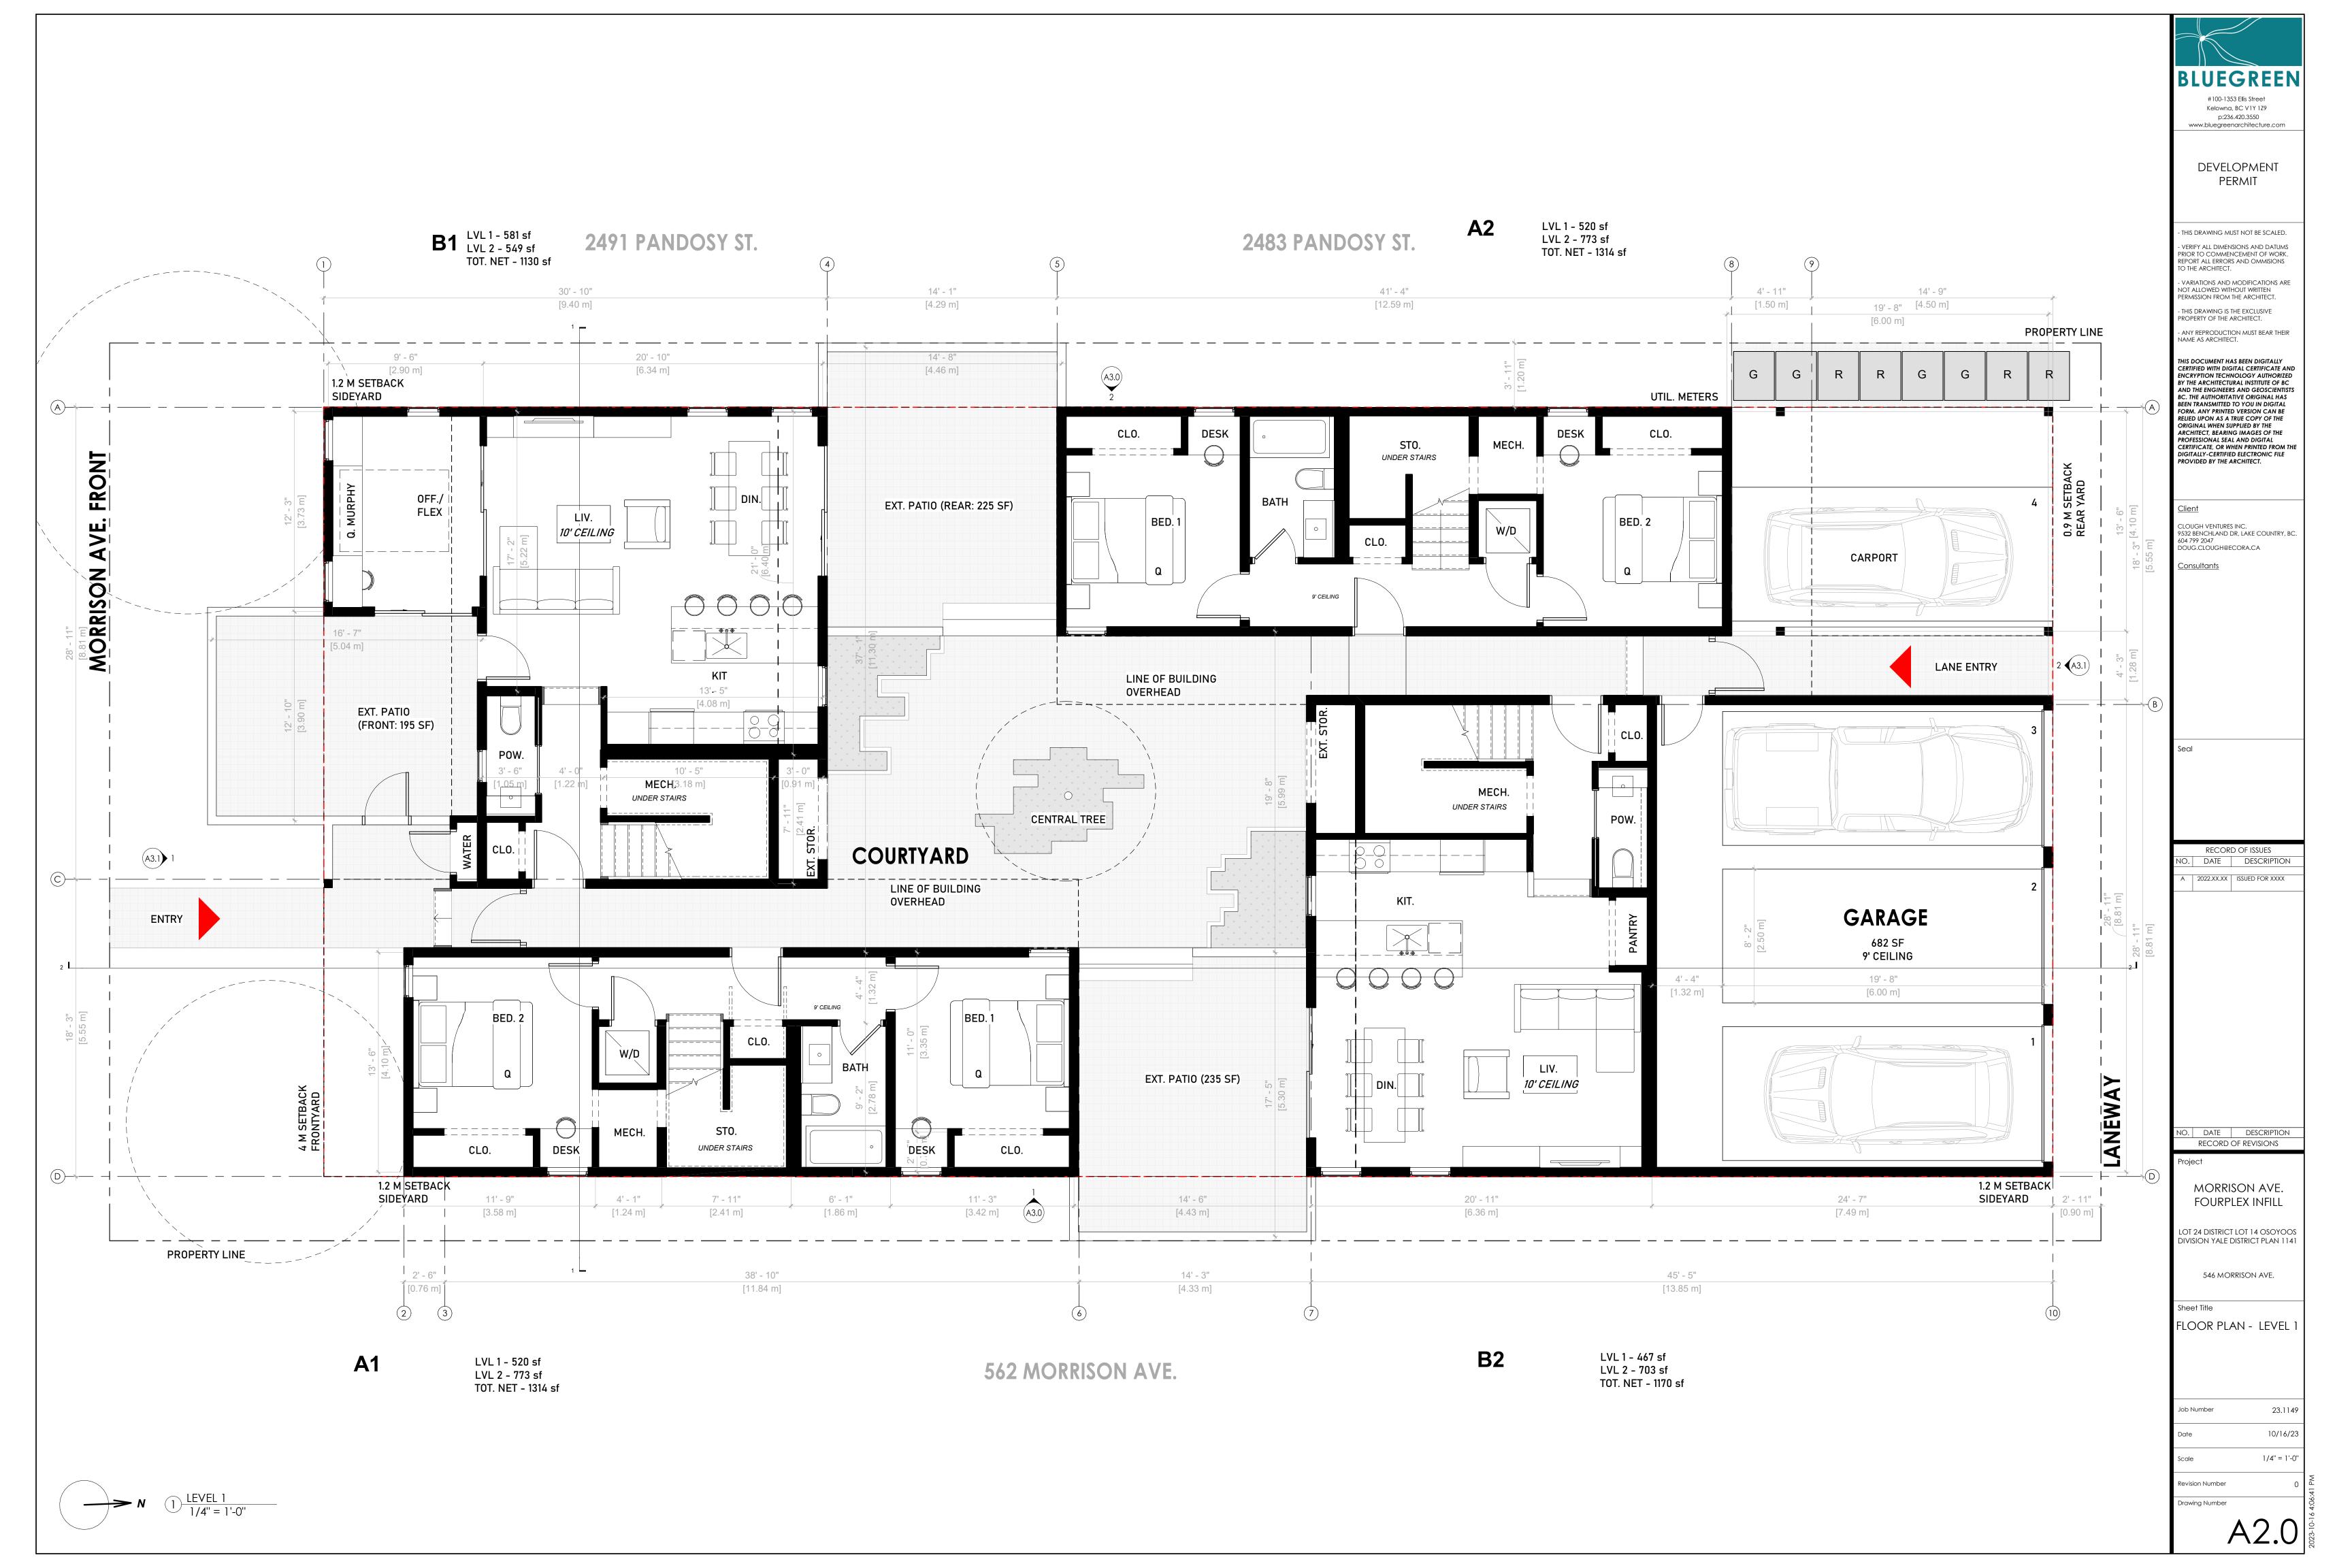
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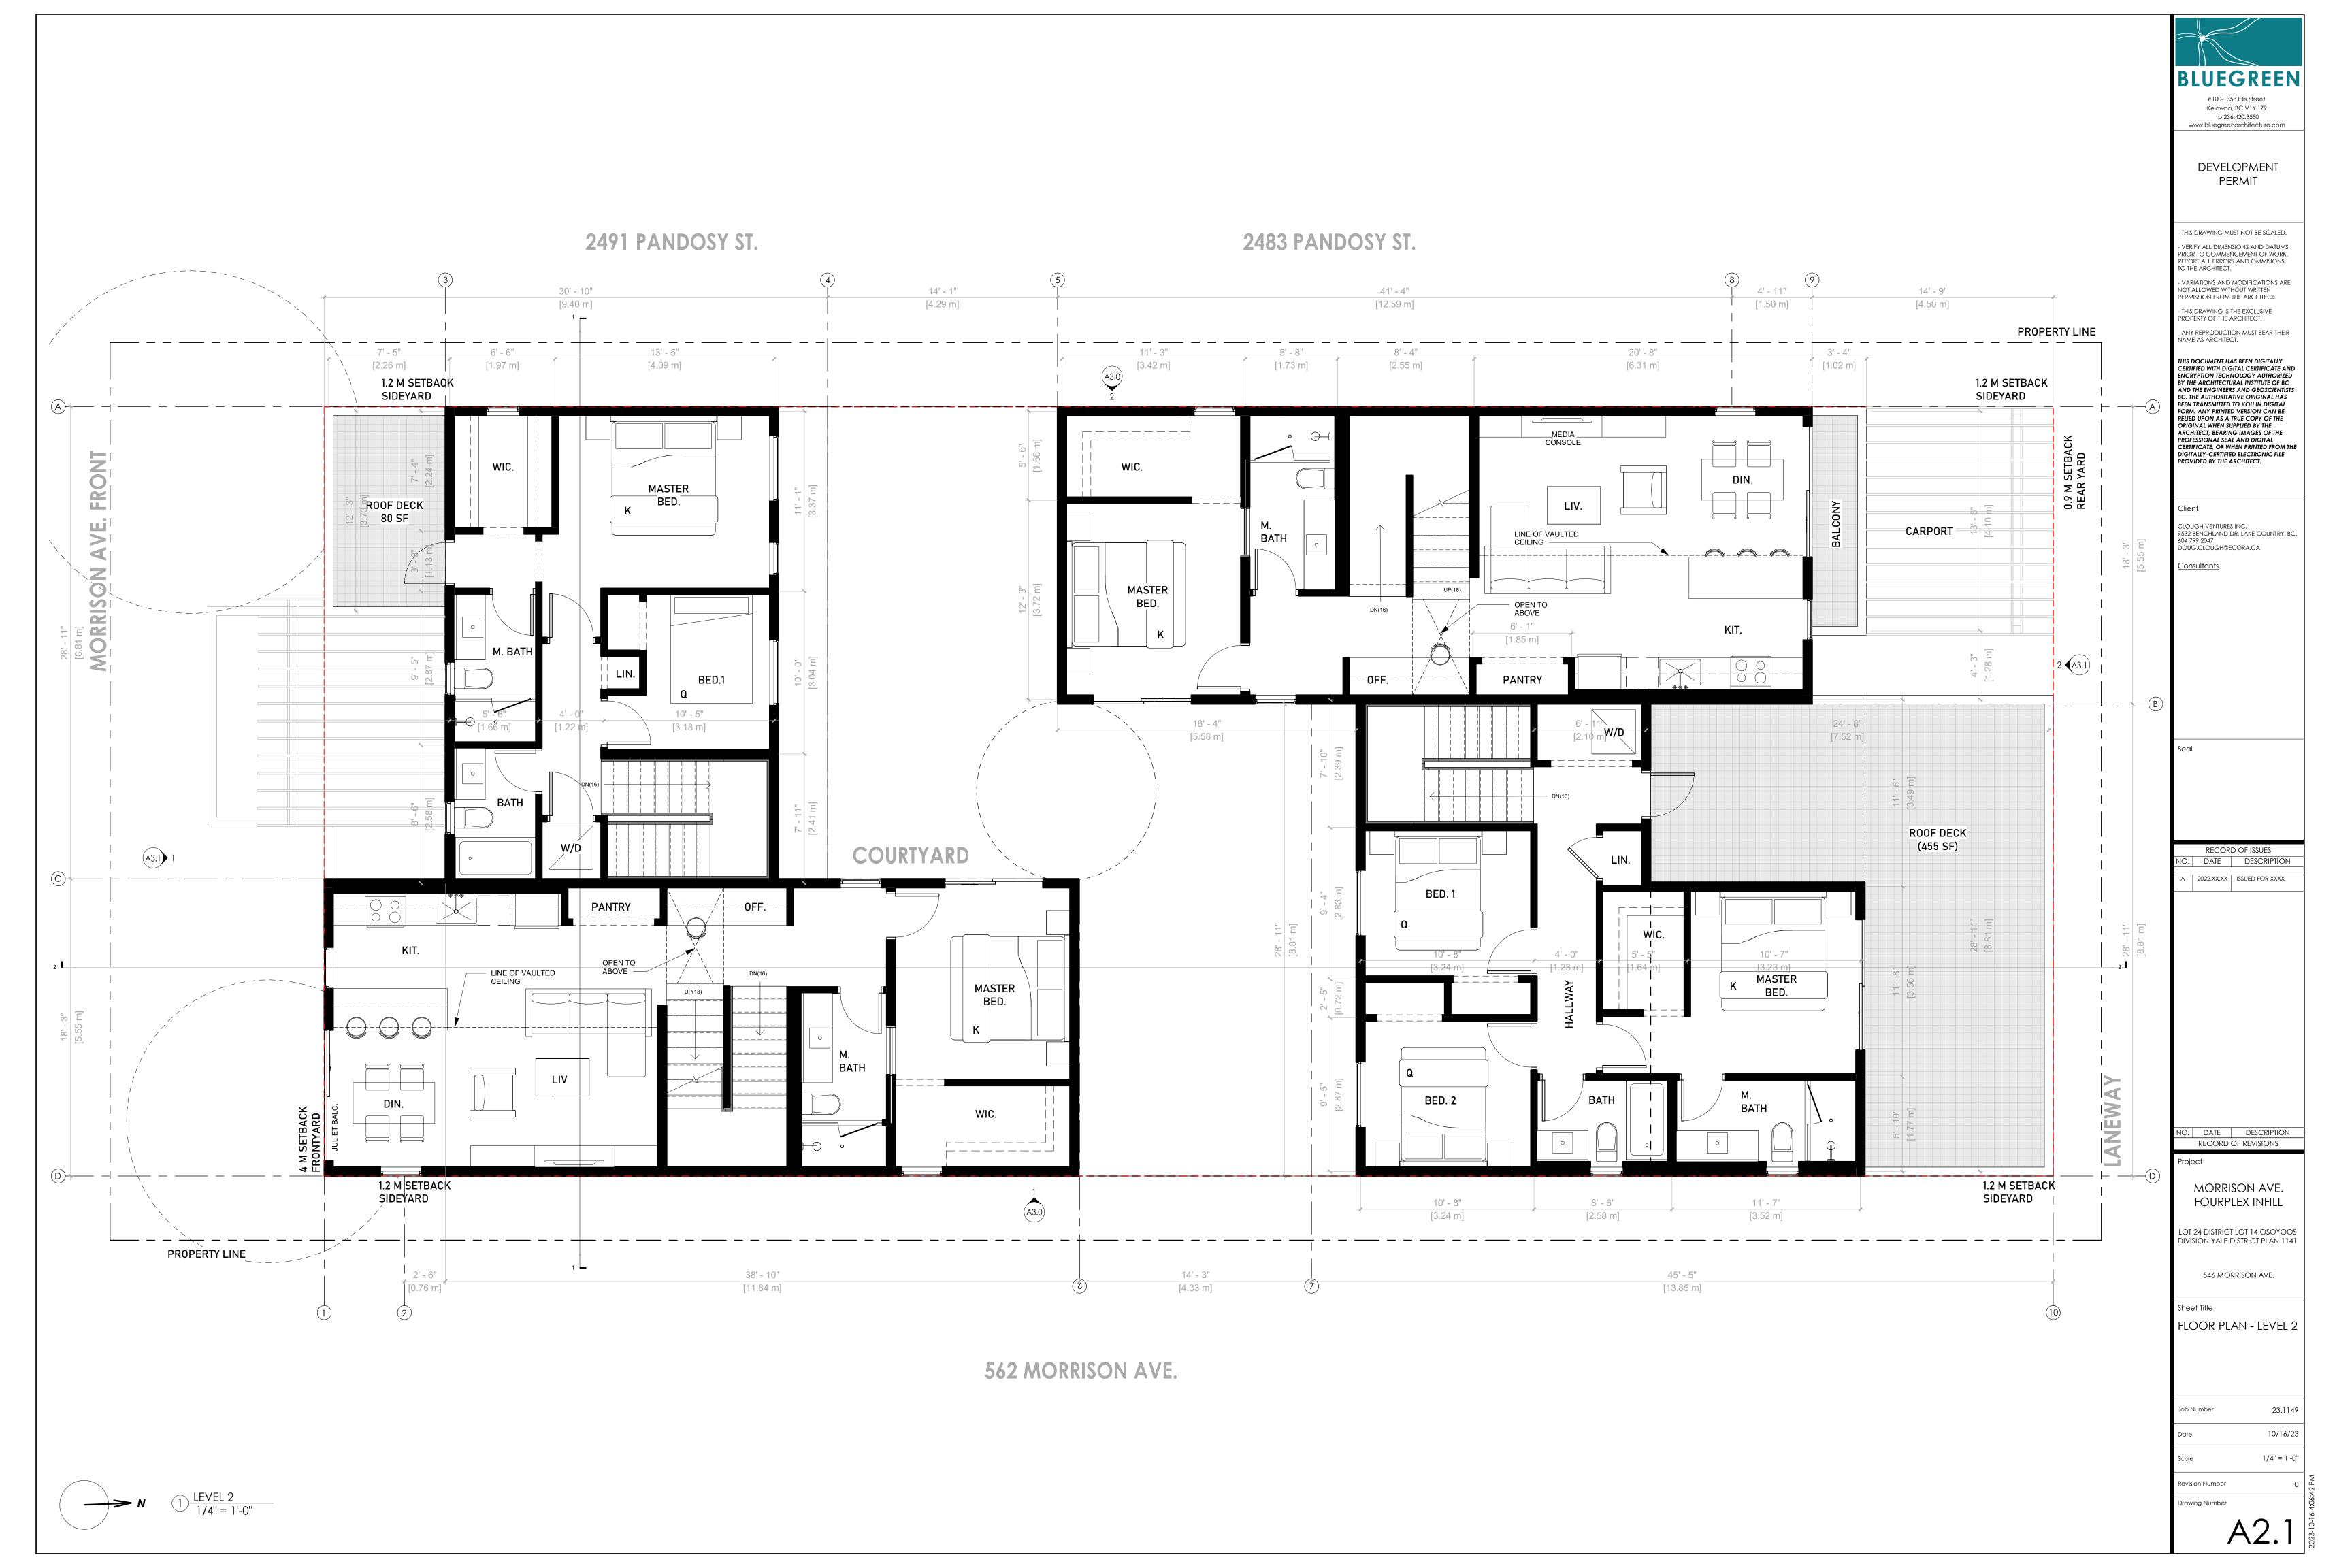
MORRISON AVE. FOURPLEX INFILL


LOT 24 DISTRICT LOT 14 OSOYOOS DIVISION YALE DISTRICT PLAN 1141

546 MORRISON AVE.

STREETFRONT





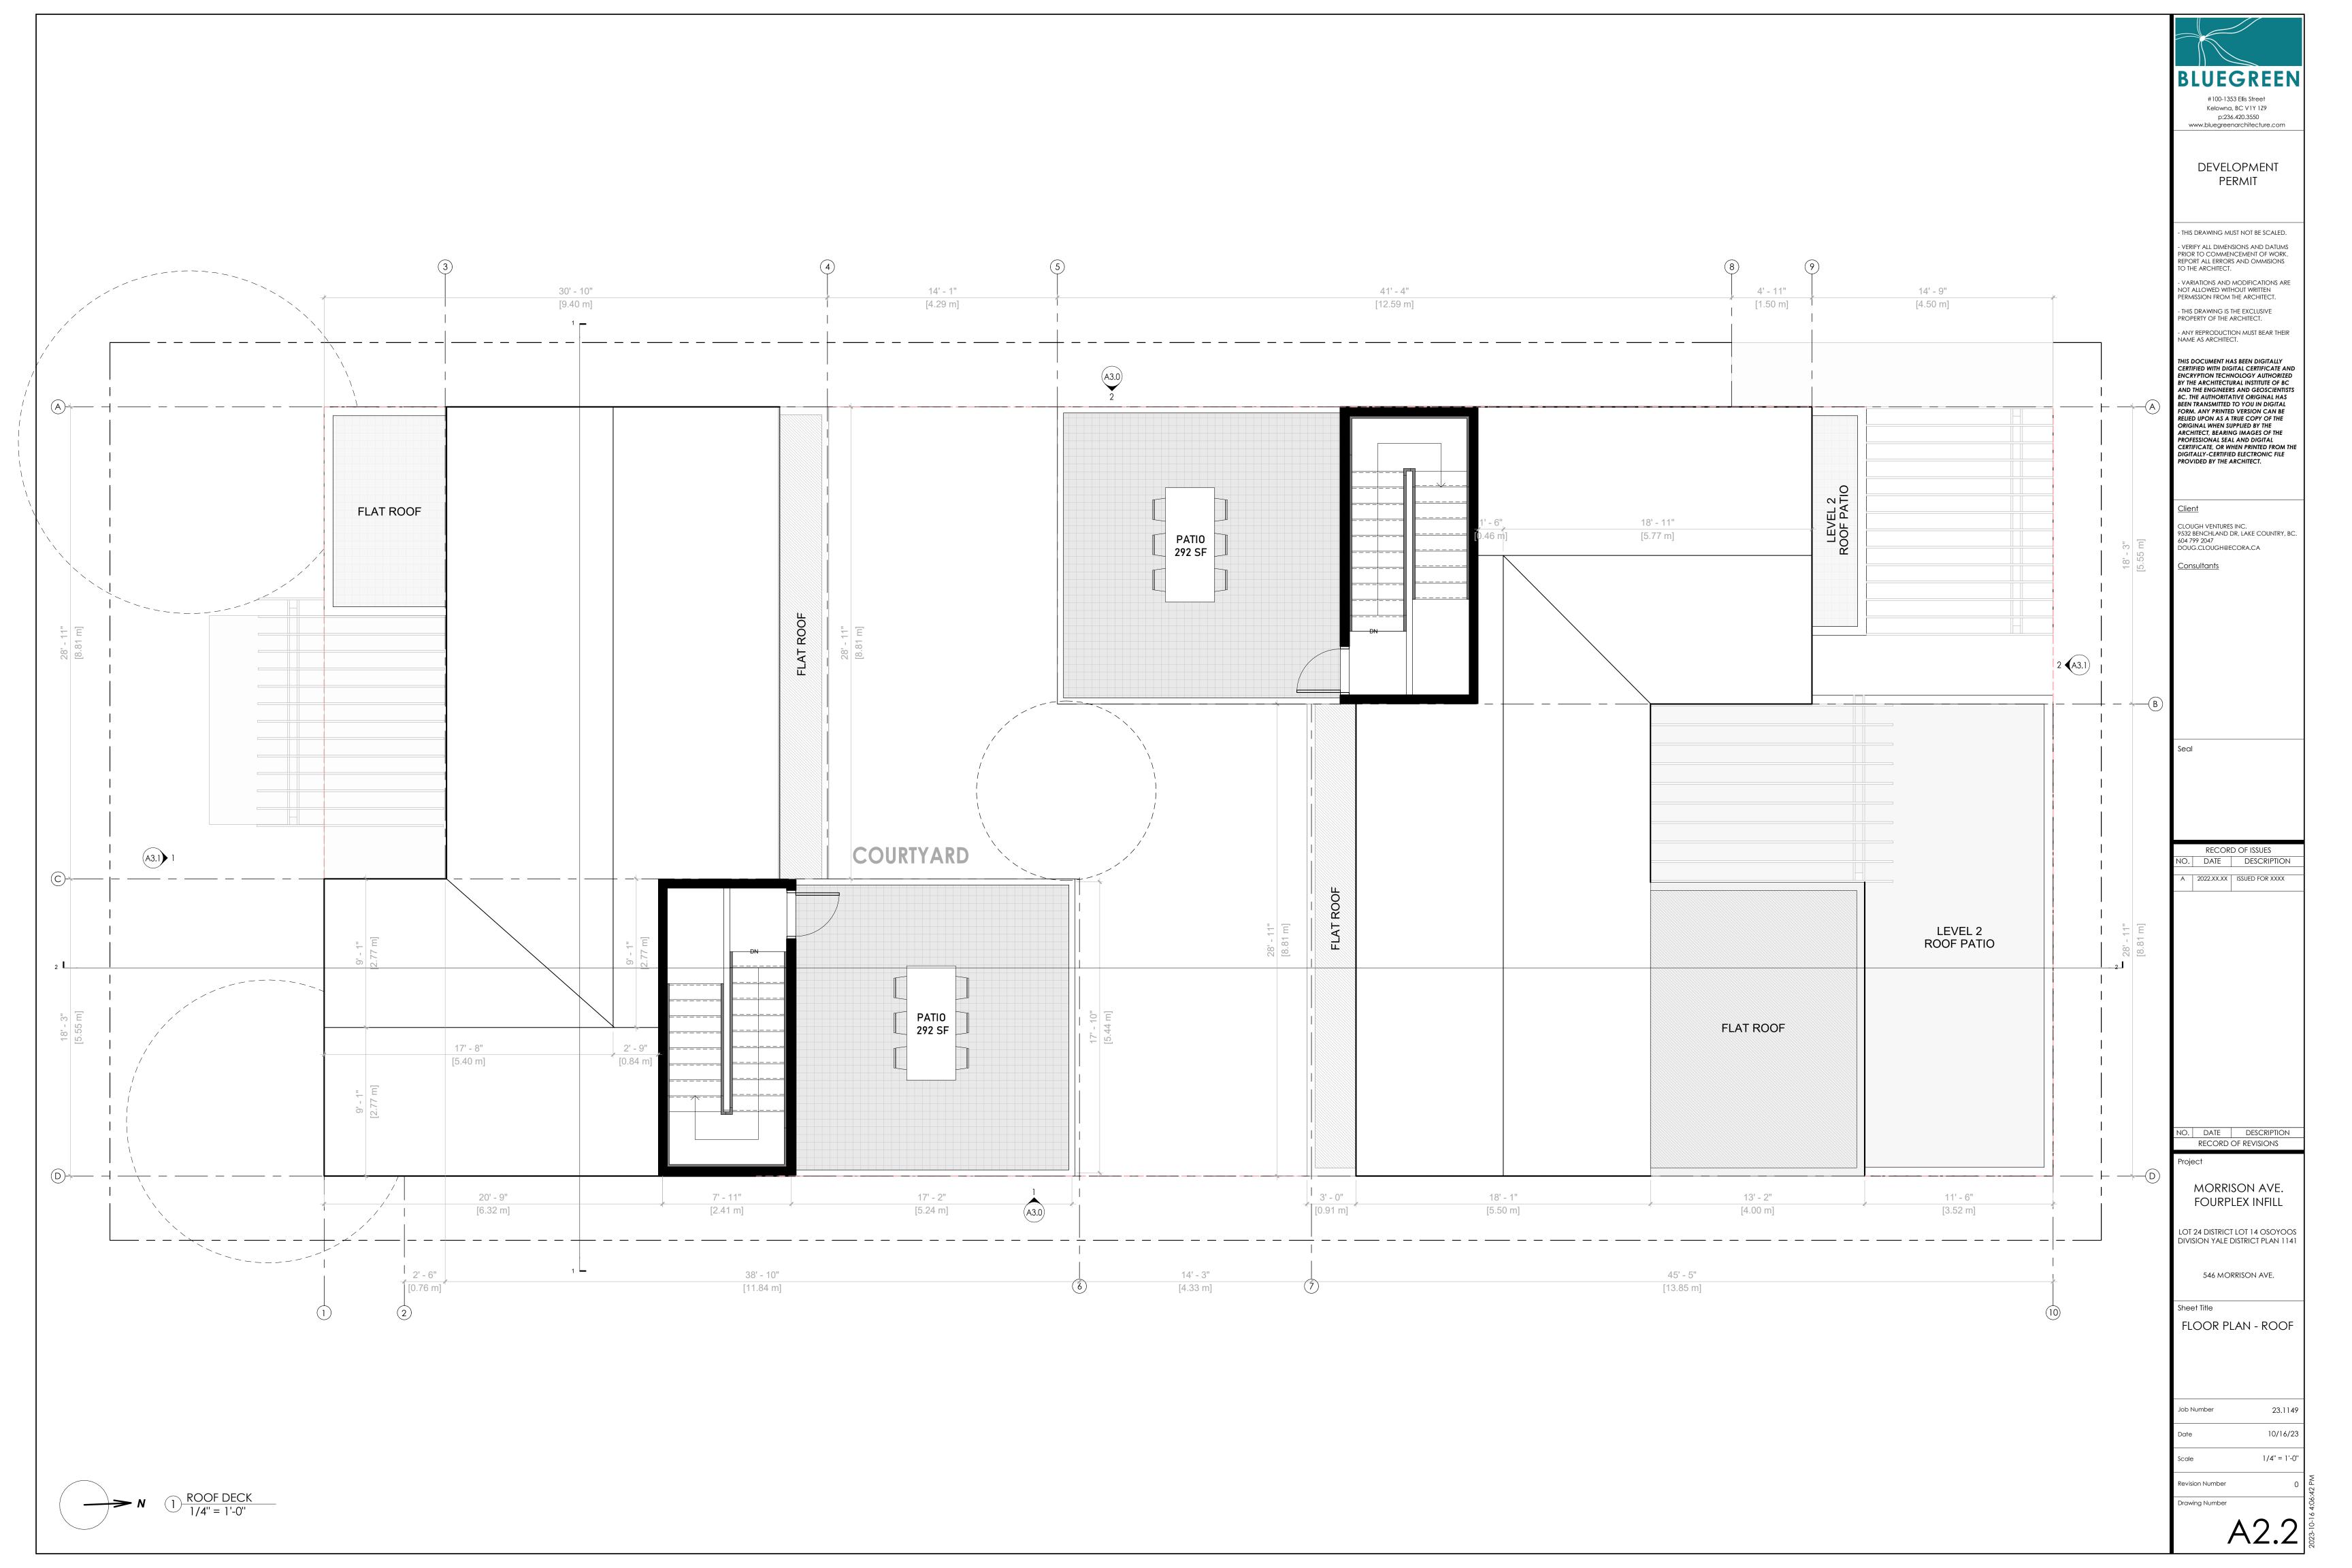





These units share all features except the balcony deck that extends out on LVL 2. of Unit A2.

On Unit A1. (facing Morrison Ave. to the South), this is a Juliet balcony.





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MORRISON AVE. FOURPLEX INFILL

LOT 24 DISTRICT LOT 14 OSOYOOS DIVISION YALE DISTRICT PLAN 1141

546 MORRISON AVE.

Sheet Title

UNIT CALLOUT

 Job Number
 23.1149


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e 1/4" = 1'-0"

Drawing Number

A2 4



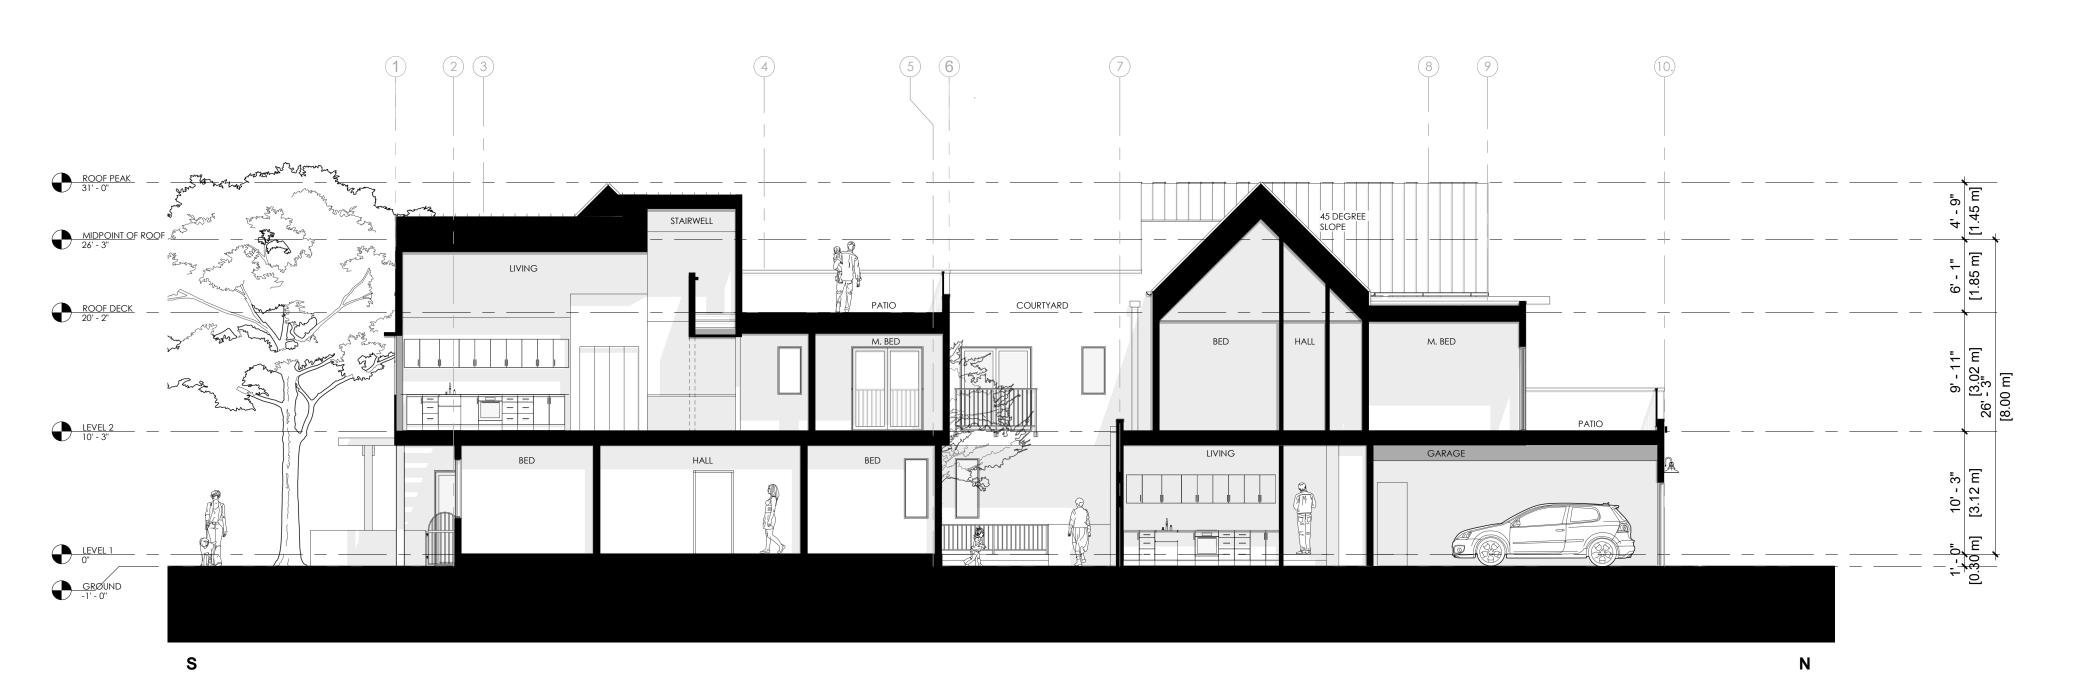

(2) North-South Section 1/8" = 1'-0"

BLUEGREEN #100-1353 Ellis Street Kelowna, BC V1Y 1Z9

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p:236.420.3550 www.bluegreenarchitecture.com

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FOURPLEX INFILL

MORRISON AVE.

LOT 24 DISTRICT LOT 14 OSOYOOS DIVISION YALE DISTRICT PLAN 1141

546 MORRISON AVE.

Sheet Title SECTIONS

23.1149 Job Number 10/16/23


1/8" = 1'-0"

Revision Number Drawing Number


ELEVATION MATERIAL LEGEND:

- ARCHITECTURALLY EXPOSED CONCRETE TYPE: MEDIUM DENISTY FORM FINISH COLOUR: NATURAL CONC.
- 2 ARCHITECTURAL WOOD FENCE
- METAL CLAD VINYL WINDOWS TYPE: EUROCLAD ALUM. HYBRID, DUAL PANE, LOW E. COLOUR: DARK GREY OR BLACK
- THERMALWOOD SIDING (WEATHERED)
 ASH SINGLE RABBET WITH CUTEK OIL
- MAC METAL ARCHITECTURAL PANEL
 MS1 PROFILE
 COLOUR: TITANIUM BLACK
- STUCCO
 TYPE FINE SAND FINISH
 COLOUR: CREAM WHITE
- 7 WOOD TRELLIS
- 8 STEEL GATE POWDERCOATED COLOUR: MELON YELLOW
- 9 EXTERIOR ACCENT FLASHING CAP COLOUR: BLACK MANUFACTURER: CASCADIA METALS
- 10 ALUMINUM RAILING COLOUR: BLACK 42" GUARD HEIGHT
- EXTERIOR ACCENT FLASHING/TRIM COLOUR COLOUR: BLACK MANUFACTURER: CASCADIA METALS
- GARAGE DOOR
 COLOUR: BLACK
 MANUFACTURER: ALUMINR



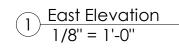



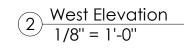



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RECORD OF ISSUES

D. DATE DESCRIPTION 2022.XX.XX | ISSUED FOR XXXX

D. DATE DESCRIPTION
RECORD OF REVISIONS

MORRISON AVE. FOURPLEX INFILL

LOT 24 DISTRICT LOT 14 OSOYOOS DIVISION YALE DISTRICT PLAN 1141

546 MORRISON AVE.


Sheet Title ELEVATIONS

23.1149

Job Number 10/16/23 As indicated

ELEVATION MATERIAL LEGEND:

- ARCHITECTURALLY EXPOSED CONCRETE
 TYPE: MEDIUM DENISTY FORM FINISH
 COLOUR: NATURAL CONC.
- 2 ARCHITECTURAL WOOD FENCE
- METAL CLAD VINYL WINDOWS TYPE: EUROCLAD ALUM. HYBRID, DUAL PANE, LOW E. COLOUR: DARK GREY OR BLACK
- THERMALWOOD SIDING (WEATHERED)
 ASH SINGLE RABBET WITH CUTEK OIL
- MAC METAL ARCHITECTURAL PANEL
 MS1 PROFILE
 COLOUR: TITANIUM BLACK
- STUCCO
 TYPE FINE SAND FINISH
 COLOUR: CREAM WHITE
- 7 WOOD TRELLIS
- 8 STEEL GATE POWDERCOATED COLOUR: MELON YELLOW
- 9 EXTERIOR ACCENT FLASHING CAP
 COLOUR: BLACK
 MANUFACTURER: CASCADIA METALS
- 10 ALUMINUM RAILING COLOUR: BLACK 42" GUARD HEIGHT
- EXTERIOR ACCENT FLASHING/TRIM COLOUR COLOUR: BLACK MANUFACTURER: CASCADIA METALS
- GARAGE DOOR
 COLOUR: BLACK
 MANUFACTURER: ALUMINR

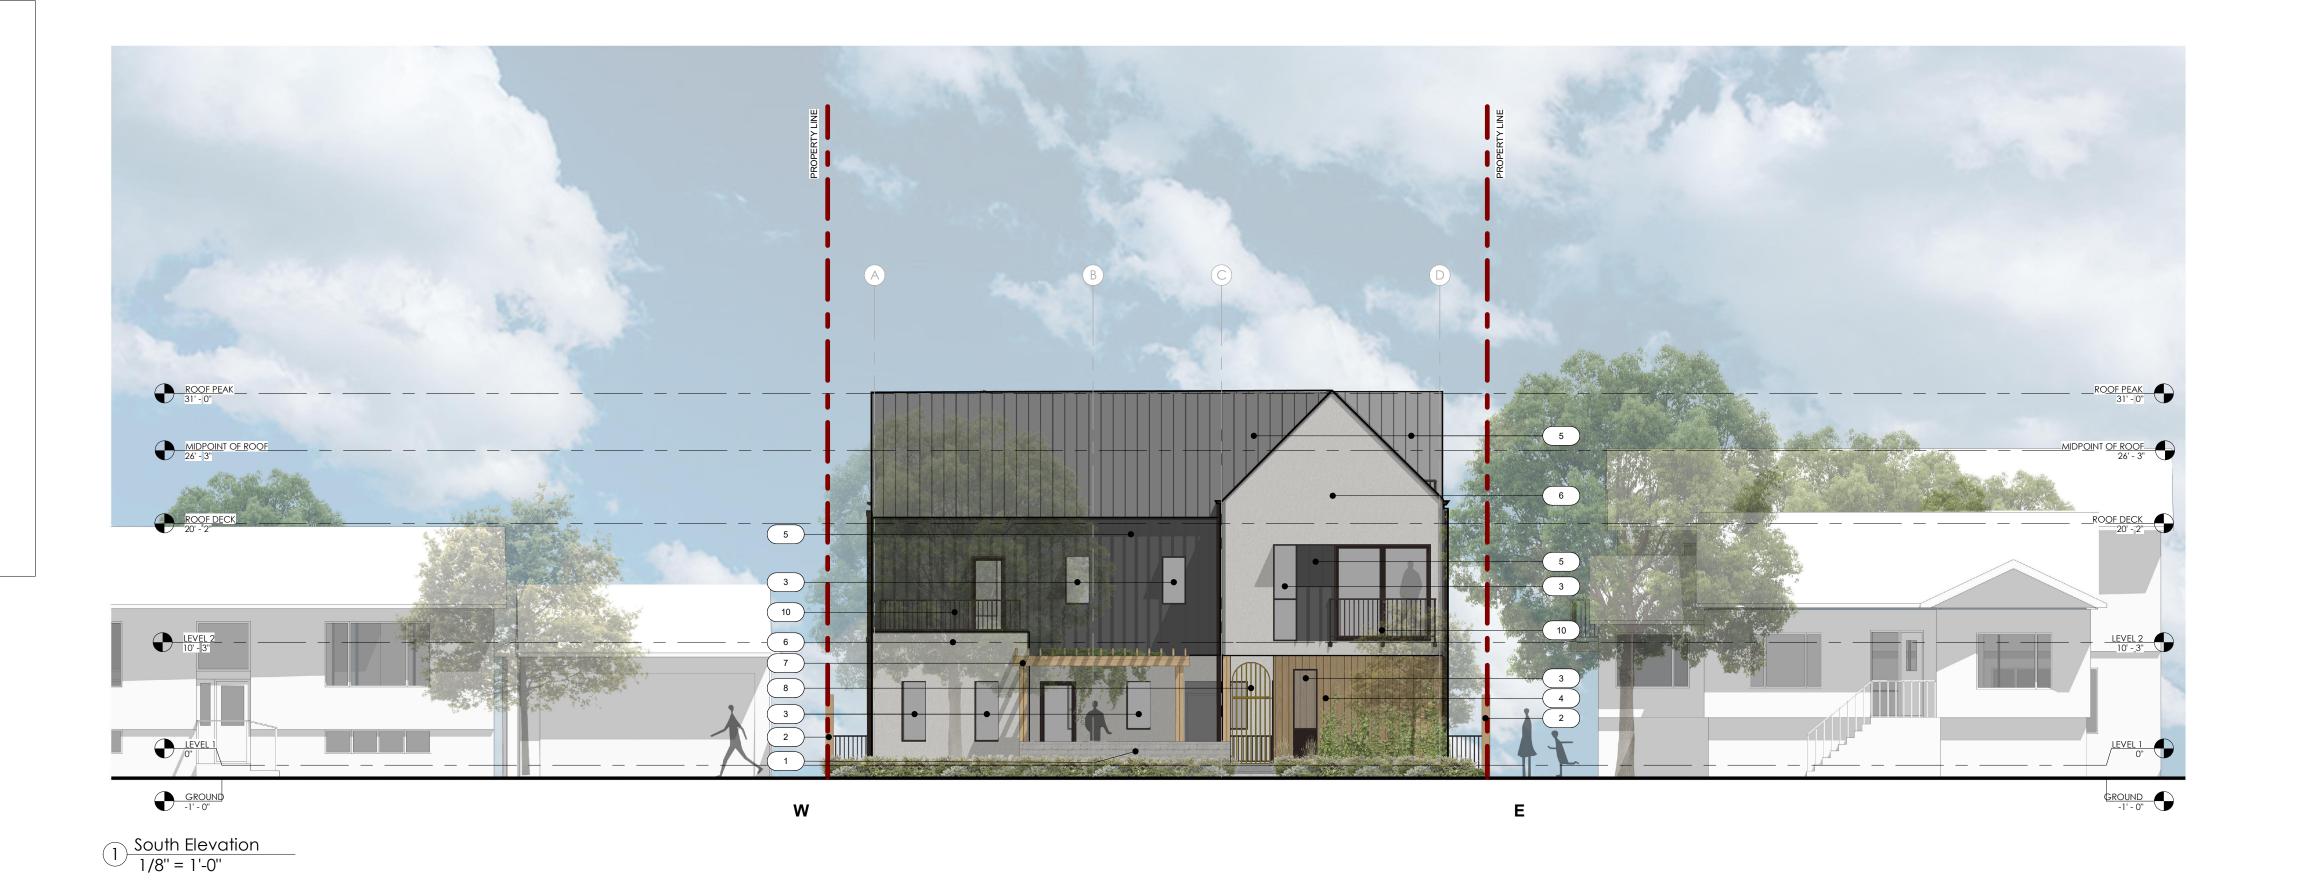



North Elevation
1/8" = 1'-0"

#100-1353 Ellis Street Kelowna, BC V1Y 1Z9 p:236.420.3550

> DEVELOPMENT PERMIT

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Sheet Title ELEVATIONS

Job Number 23.1149 10/16/23

As indicated

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2 ARCHITECTURAL WOOD FENCE

METAL CLAD VINYL WINDOWS
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COLOUR: DARK GREY OR BLACK

THERMALWOOD SIDING (WEATHERED)
ASH SINGLE RABBET WITH CUTEK OIL

MAC METAL ARCHITECTURAL PANEL
MS1 PROFILE
COLOUR: TITANIUM BLACK

STUCCO
TYPE – FINE SAND FINISH
COLOUR: CREAM WHITE

7 WOOD TRELLIS

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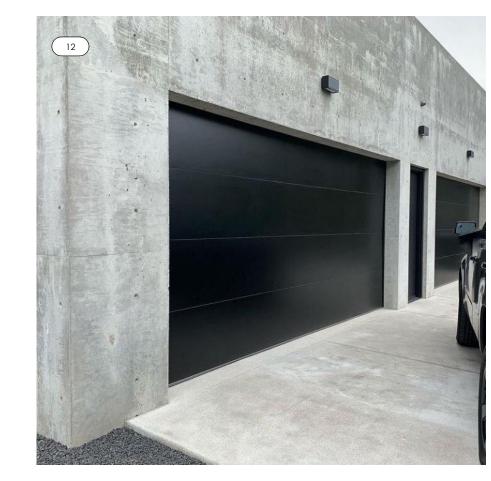
EXTERIOR ACCENT FLASHING/TRIM COLOUR COLOUR: BLACK MANUFACTURER: CASCADIA METALS

GARAGE DOOR
COLOUR: BLACK
MANUFACTURER: ALUMINR















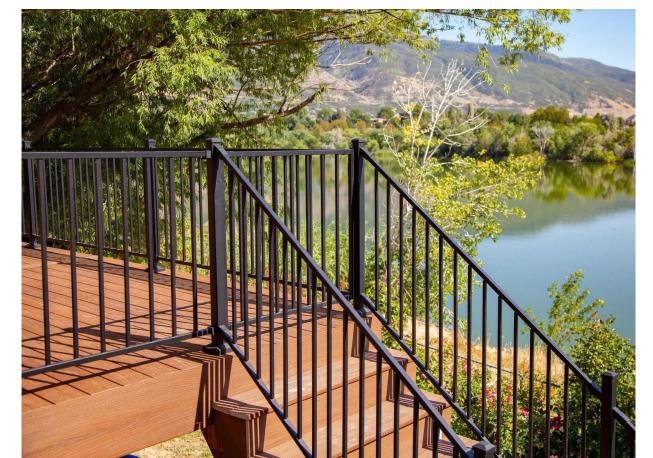



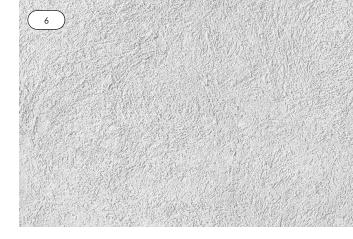

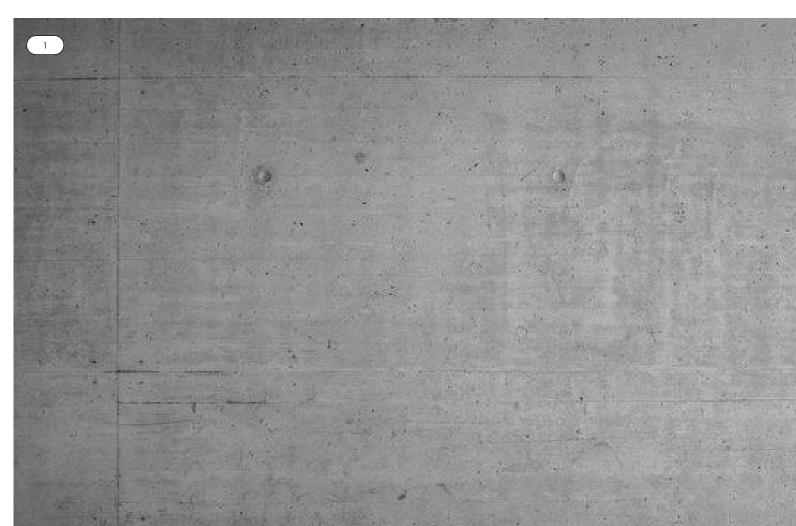

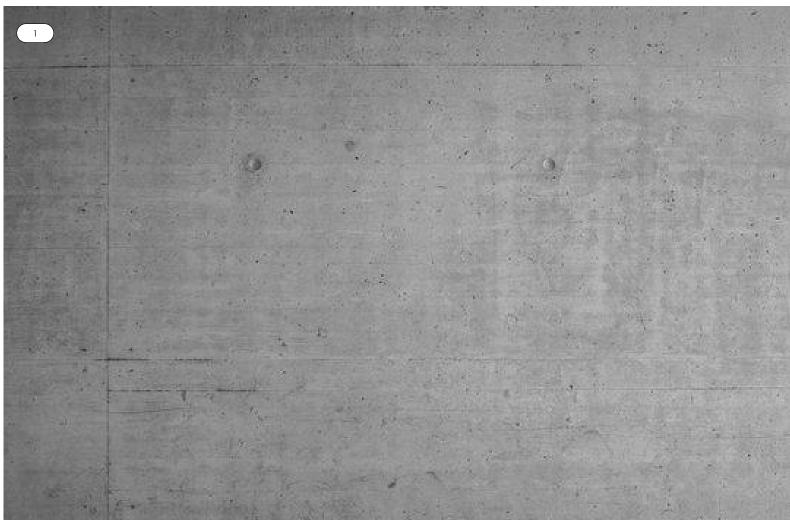







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MORRISON AVE.

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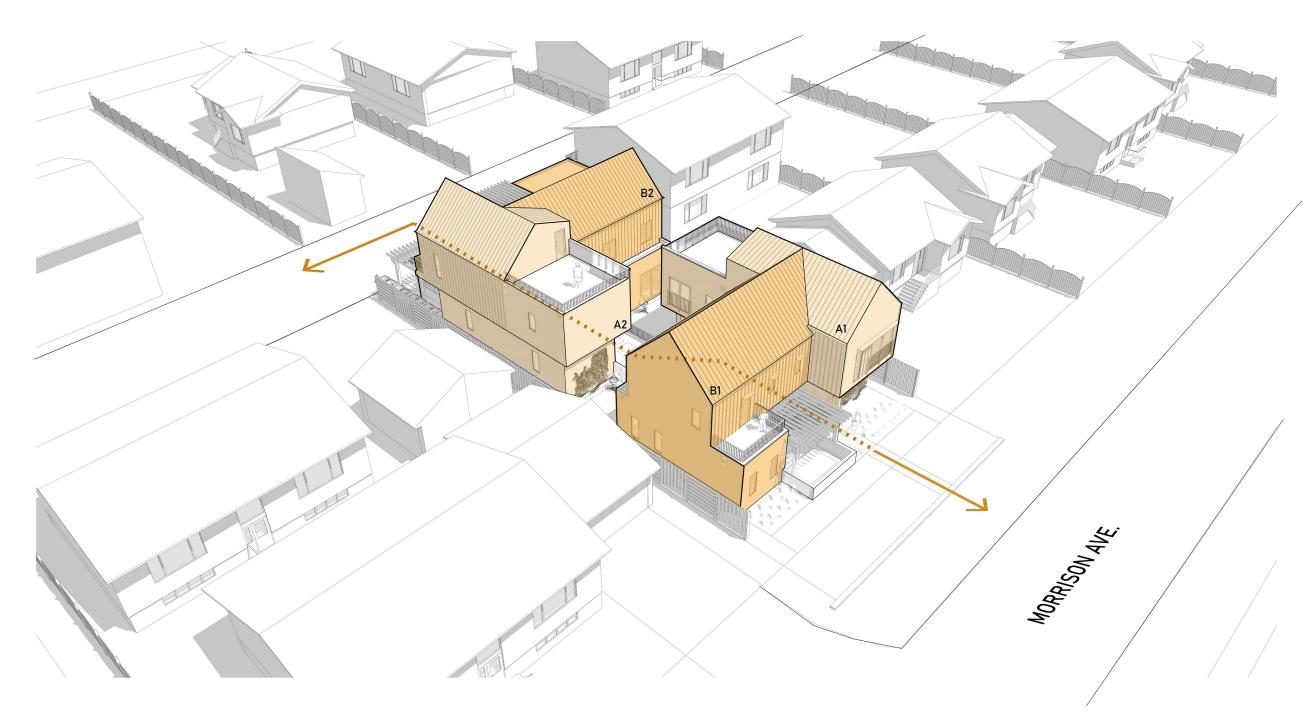
546 MORRISON AVE.

Sheet Title MATERIAL BOARD


Job Number 23.1149

10/16/23 As indicated

Revision Number



AERIAL - UNITS AND INTERSECTING PATHWAY

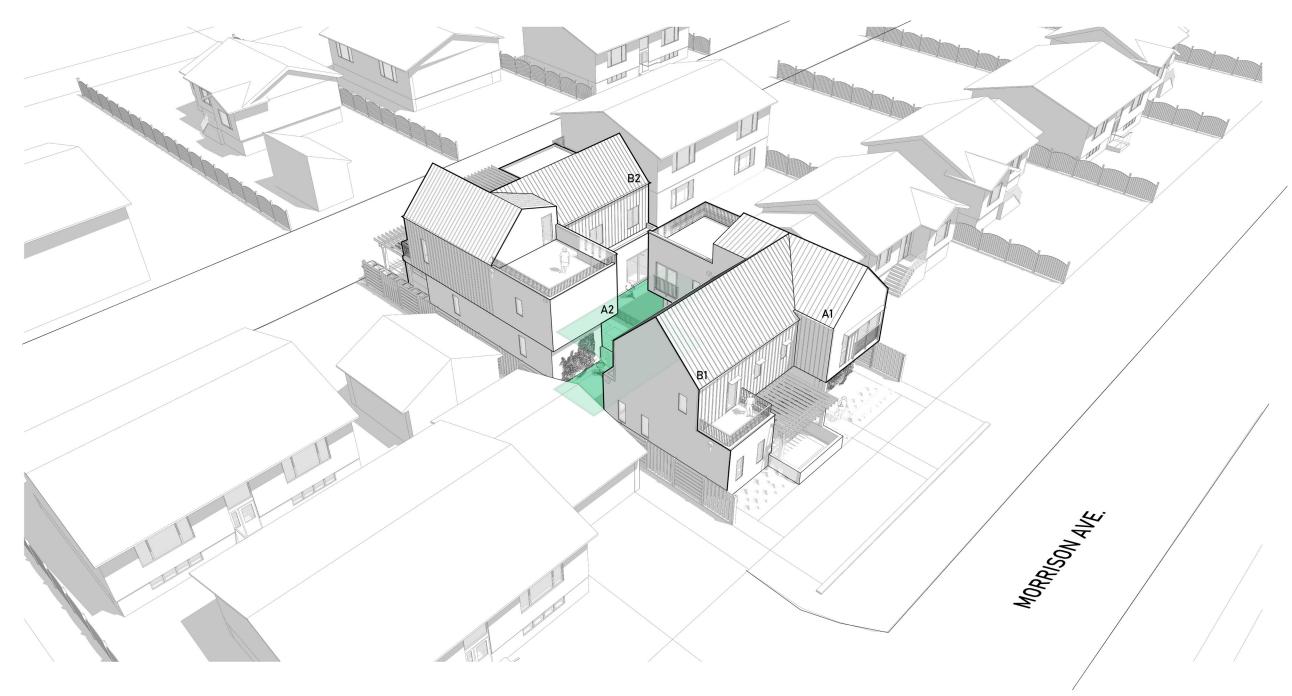

AERIAL - COURTYARD



RENDER - FRONT (MORRISON AVE.)



RENDER - FRONT (MORRISON AVE.)



RENDER - REAR



DEVELOPMENT PERMIT

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546 MORRISON AVE.

Sheet Title RENDERS

23.1149

5 10 15 20 25 M



NOTES

1. PLANT MATERIAL AND CONSTRUCTION METHODS SHALL MEET OR EXCEED CANDAIAN LANDSCAPE STANDARDS. ALL OFFSITE LANDSCAPE WORKS TO MEET CITY OF KELOWNA BYLAW 12375 STANDARDS.

2. ALL SOFT LANDSCAPE AREAS SHALL BE WATERED BY A FULLY AUTOMATIC TIMED UNDERGROUND IRRIGATION SYSTEM.

3. TREE AND SHRUB BEDS TO BE DRESSED IN A MINIMUM 75mm NATURAL WOOD MULCH AS SHOWN IN PLANS. DO NOT PLACE WEED MAT UNDERNEATH TREE AND SHRUB BEDS.

4. SHRUB BEDS TO RECEIVE A MINIMUM 300mm DEPTH TOPSOIL PLACEMENT. TREE BEDS TO RECEIVE A MINIMUM 1000mm DEPTH TOPSOIL PLACEMENT.

5. TURF AREA FROM SOD SHALL BE NO.1 GRADE GROWN FROM CERTIFIED SEED OF IMPROVED CULTIVARS REGISTERED FOR SALE IN B.C. AND SHALL BE TOLERANT OF DROUGHT CONDITIONS. A MINIMUM OF 150mm DEPTH OF GROWING MEDIUM IS REQUIRED BENEATH TURF AREAS. TURF AREAS SHALL MEET EXISTING GRADES AND HARD SURFACES FLUSH.

6. SITE GRADING AND DRAINAGE WILL ENSURE THAT ALL STRUCTURES HAVE POSITIVE DRAINAGE AND THAT NO WATER OR LOOSE IMPEDIMENTS WILL BE DISCHARGED FROM THE LOT ONTO ADJACENT PUBLIC, COMMON, OR PRIVATE PROPERTIES.

7. FOR CONFORMANCE WITH DEVELOPMENT PERMIT LANDSCAPE REQUIREMENTS, THE PRIME CONTRACTOR AND/OR CONSULTANTS REPONSIBLE FOR SITE SERVICING AND UTILITIES SHALL ENSURE THAT ALL BUILDING PERMIT SUBMITTALS ARE COORDINATED WITH LANDSCAPE ARCHITECTURAL SUBMITTALS.

| BOTANICAL NAME | COMMON NAME | QTY | SIZE/SPACING & REMARKS |
|--|--------------------------------------|-----|------------------------------|
| TREES | | | |
| ACER PALMATUM 'TWOMBLY'S RED SENTINEL' | TWOMBLYS RED SENTINEL JAPANESE MAPLE | 1 | 3cm CAL. /PER PLAN |
| ACER SACCHARINUM 'SILVER CLOUD' | SILVER CLOUD MAPLE | 1 | 5cm CAL. /PER PLAN |
| CARPINUS BETULUS 'FRANS FONTAINE' | FRANS FONTAINE EUROPEAN HORNBEAM | 1 | 4cm CAL. /PER PLAN |
| SHRUBS | | | |
| ROSA WOODSII | WOOD'S ROSE | 1 | #02 CONT. /1.5M O.C. SPACIN |
| SYMPHORICARPOS ALBUS | WHITE SNOWBERRY | 3 | #02 CONT. /1.0M O.C. SPACIN |
| PERENNIALS & ORNAMENTAL GRASSES | | | |
| ECHINACEA PURPUREA 'ALBA' | WHITE SWAN CONEFLOWER | 13 | #01 CONT. /0.6M O.C. SPACIN |
| ECHINACEA PURPUREA 'MAGNUS' | MAGNUS CONEFLOWER | 30 | #01 CONT. /0.4M O.C. SPACIN |
| ECHINACEA PURPUREA 'PURPLE EMPEROR' | PURPLE EMPEROR CONEFLOWER | 13 | #01 CONT. /0.6M O.C. SPACIN |
| HEMEROCALLIS 'CHICAGO PICOTE' | CHICAGO PICOTE DAYLILY | 8 | #01 CONT. /0.75M O.C. SPACII |
| HEMEROCALLIS 'LUXURY LACE' | LUXURY LACE DAYLILY | 6 | #01 CONT. /0.9M O.C. SPACIN |
| HEMEROCALLIS 'PARDON ME' | PARDON ME DAYLILY | 8 | #01 CONT. /0.75M O.C. SPACII |
| LAVENDULA ANGUSTIFOLIA 'HIDCOTE SUPERIOR' | HIDCOTE SUPERIOR LAVENDER | 13 | #01 CONT. /0.6M O.C. SPACIN |
| PACHYSANDRA TERMINALIS | JAPANESE PACHYSANDRA | 53 | #01 CONT. /0.3M O.C. SPACIN |
| RUDBECKIA FULGIDA 'GOLDSTURM' | BLACK-EYED SUSAN | 19 | #01 CONT. /0.5M O.C. SPACIN |
| PANICUM VIRGATUM 'HANSE HERMS' | Hanse Herms Switch Grass | 15 | #01 CONT. /AS PER PLAN |
| CALAMAGROSTIS X ACUTIFLORA 'KARL FOERSTER' | Karl Foerster Reed Grass | 13 | #01 CONT. /0.6M O.C. SPACIN |



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PROJECT TITLE

546 MORRISON AVE.

Kelowna, BC

WITH ADJACENT PROPERTY

DRAWING TITLE

CONCEPTUAL LANDSCAPE PLAN

ISSUED FOR / REVISION
1 23.09.25

| | /N BY | JN | |
|------------|---------|---------|--|
| DESIC | 1 1 0 1 | | |
| DESIGN BY | | AM | |
| PROJECT NO | | 23-0561 | |

| design by | AM |
|------------|----------------|
| DRAVVN BY | JN |
| CHECKED BY | FB |
| DATE | SEPT. 25, 2023 |
| SCALE | 1:75 |
| PAGE SIZE | 24x36 |

SEAL



drawing number

LS-101

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